

# WASHINGTON DEPARTMENT OF FISH AND WILDLIFE

SUMMIT LAKE ACCESS SITE RENOVATION TN:A562:12-1

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### **ABBREVIATIONS**

ALUM — ALUMINUM ANGLE

APPROX.- APPROXIMATELY BENCH MARK CENTERLINE

CLEARANCE

CMP - CORRUGATED METAL PIPE

CONC - CONCRETE CORRUGATED POLYPROPYLENE PIPE

DIAMETER ELEV - ELEVATION

EXISTING EDGE OF PAVEMENT

FLAT BAR

FOOTING GALV - GALVANIZED

GAUGE HDPE - HIGH DENSITY POLYETHYLENE

 STRUCTURAL TUBING INSIDE DIAMETER INVERT ELEVATION

LONG MACHINE BOLT – MANUFACTURER'S

MINIMUM MISC. - MISCELLANEOUS MOD. – MODEL

ON CENTER

 ORIENTED STRAND BOARD OUTSIDE DIAMETER

PAV'T - ASPHALT CONCRETE PAVEMENT PLATE

PT - PRESSURE TREATED REQ'D - REQUIRED

SECTION SQUARE FEET SHT. - SHEET

SPEC'S. - PROJECT SPECIFICATIONS

STD - STANDARD S.S. - STAINLESS STEEL

TESC - TEMPORARY EROSION & SEDIMENT CONTROL

TYP – TYPICAL W.S. - WATER SURFACE

WSDOT - WASHINGTON STATE

DEPARTMENT OF TRANSPORTATION

### SHEET SYMBOLS

DETAIL DESIGNATION

SHEET CALLED FROM-SHEET LOCATED ON


#### **DETAIL**

SECTION DESIGNATION SHEET CALLED FROM -SHEET LOCATED ON

NOTE REFERENCE

APPEARING ON SAME SHEET OR A


PART OR MATERIAL IN A SCHEDULE

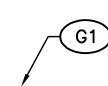

REFERENCE DESIGNATION TO NOTE

PROJECT NO.

TN:A562:12-

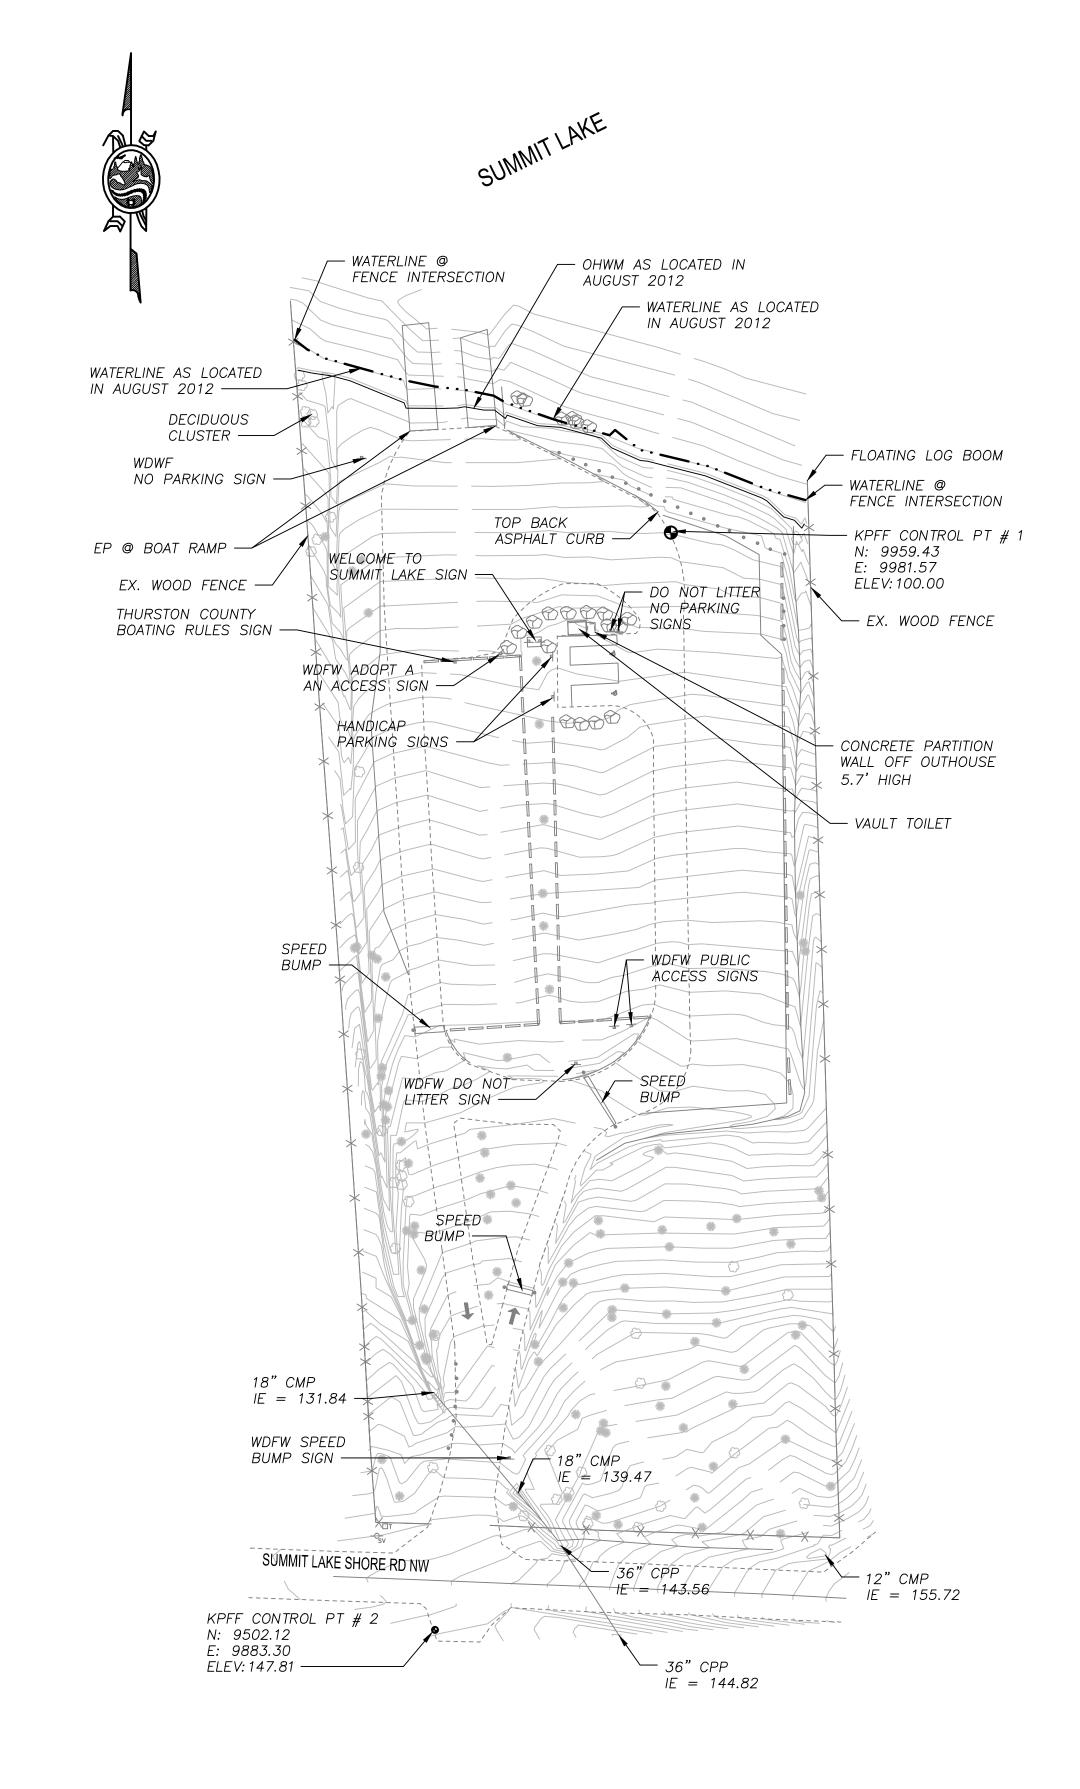

SITE LOCATION

SAN JUN SICHEL

SIANG

SITE LOCATION

CLALLAM

CHEAN

CHEAN

CHEAN

DOUGLAS

HITTITIAS

GRANT

ADMIS

WHITIMAN

PROFIC

LEWIS


WHATIMAN

COULITZ

SKAMANIA

KLICKITAT

STATE MAP
NOT TO SCALE

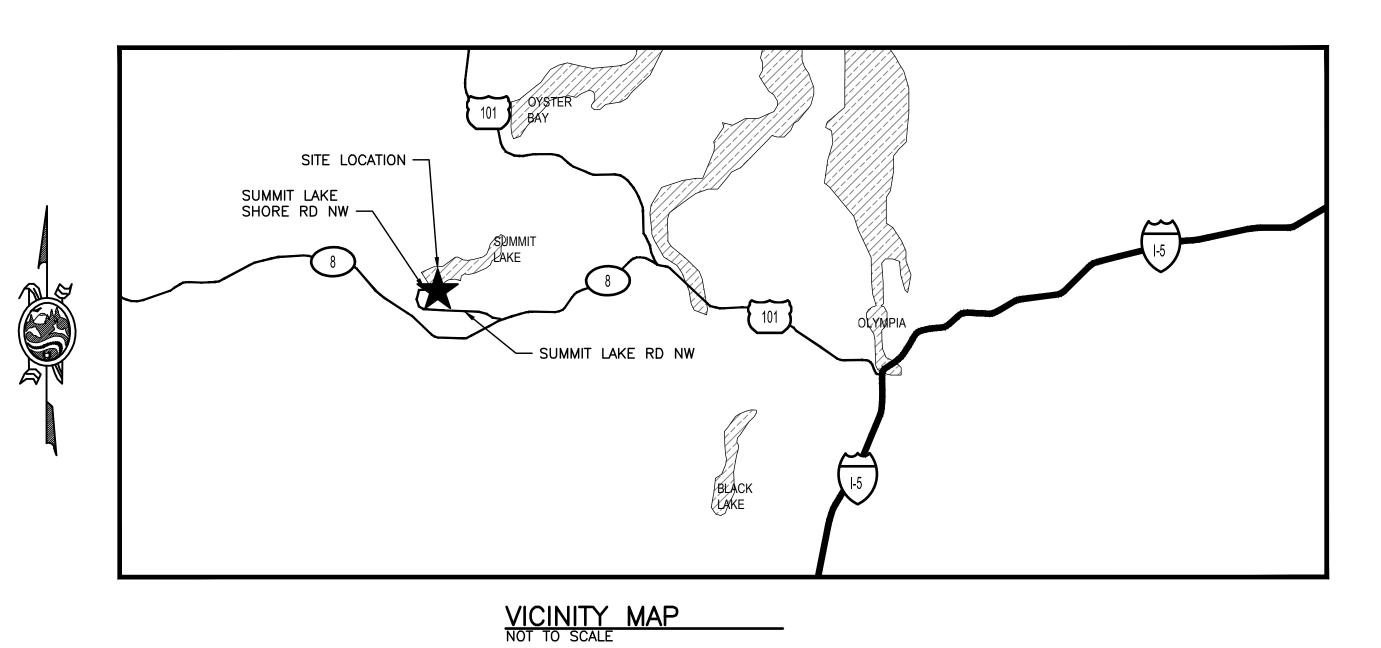

GRAPHIC SCALE

40 0 20 40 80 16

(IN FEET )
1 inch = 40 ft.


EXISTING SITE PLAN
SCALE: 1" = 40"

Consulting Engineers

2407 North 31st Street, Suite 100
Tacoma, Washington 98407
(253) 396-0150
Fax (253) 396-0162

WASHINGTON STATE

DEPARTMENT OF FISH AND WILDLIFE

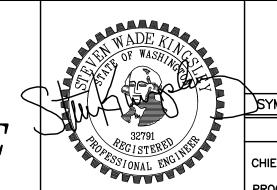

					BAR MEASURES ONE INCH ON ORIGINAL DRAWINGS
	SYM	DATE	REVISION DESCRIPTION	BY	DESIGNED BY MRK
/ 1			APPROVED AND RELEASED FOR CONSTRUCTION		CHECKED BY SWK  DRAWN BY MRK
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	   PROGRA	M			DATE 01/31/13

SUMMIT LAKE, ACCESS

ONE INCH ON
RIGINAL DRAWINGS

SITE RENOVATION

ED BY MRK
ED BY SWK

EXISTING SITE PLAN & VICINITY MAP

TN:A562:12-1

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PROJECT NO.

#### GENERAL NOTES

- 1. BEFORE ANY CONSTRUCTION OR DEVELOPMENT ACTIVITY. A PRE-CONSTRUCTION MEETING MUST BE HELD BETWEEN THE COUNTY, WDFW AND THE CONTRACTOR.
- 2. A COPY OF THESE APPROVED PLANS MUST BE ON THE JOB SITE WHENEVER CONSTRUCTION IS IN
- 3. GRADING ACTIVITIES (SITE ALTERATION) ARE LIMITED TO THE HOURS OF 7 A.M. TO 7 P.M. MONDAY THROUGH SATURDAY AND 10 A.M. TO 5 P.M. ON SUNDAY, UNLESS OTHERWISE APPROVED WITH A WRITTEN DECISION BY THE REVIEWING AGENCY.
- 4. IT SHALL BE THE APPLICANT'S/CONTRACTOR'S RESPONSIBILITY TO OBTAIN ALL CONSTRUCTION EASEMENTS NECESSARY BEFORE INITIATING OFF-SITE WORK. EASEMENTS REQUIRE REVIEW AND APPROVAL PRIOR TO CONSTRUCTION.
- 5. ALL UTILITY TRENCHES AND ROADWAY SUBGRADE SHALL BE BACKFILLED AND COMPACTED TO 95 PERCENT DENSITY, STANDARD PROCTOR.
- 6. THE CONTRACTOR SHALL BE RESPONSIBLE FOR PROVIDING ADEQUATE SAFEGUARDS, SAFETY DEVICES, PROTECTIVE EQUIPMENT, FLAGGERS, AND ANY OTHER NEEDED ACTIONS TO PROTECT THE LIFE, HEALTH, AND SAFETY OF THE PUBLIC, AND TO PROTECT PROPERTY IN CONNECTION WITH THE PERFORMANCE OF WORK COVERED BY THE CONTRACTOR, ANY WORK WITHIN THE TRAVELED RIGHT-OF-WAY THAT MAY INTERRUPT NORMAL TRAFFIC FLOW SHALL REQUIRE AT LEAST ONE FLAGGER FOR EACH LANE OF TRAFFIC AFFECTED. MANUAL ON UNIFORM TRAFFIC CONTROL DEVICES (MUTCD) SHALL APPLY. WORK IN RIGHT-OF-WAY IS NOT AUTHORIZED UNTIL A TRAFFIC CONTROL PLAN IS APPROVED BY THURSTON COUNTY.

#### **SURVEY NOTES:**

- 1. BASIS OF BEARING IS ASSUMED.
- 2. VERTICAL DATUM IS ASSUMED.
- 3. ASSUMPTIONS ARE BASED OFF OF KPPF CONTROL PT #1 AND KPFF CONTROL POINT #2.
- 4. BASE MAP HAS BEEN DEVELOPED FROM TOPOGRAPHIC SURVEY PERFORMED BY KPFF CONSULTING ENGINEERS IN AUGUST 2012.
- 5. UNDERGROUND UTILITIES ARE NOT A PART OF THIS SURVEY, ONLY SURFACE FEATURE ARE SHOWN.

#### **UTILITY NOTES:**

- 1. THE EXISTENCE, LOCATION AND CHARACTERISTICS OF UNDERGROUND UTILITIES CONDUITS AND PIPES SHOWN ON THESE PLANS ARE NOT SHOWN. NO REPRESENTATION IS MADE AS TO THE ACCURACY OR COMPLETENESS OF SAID UTILITY INFORMATION. THE CONTRACTOR SHALL POTHOLE OR OTHERWISE CONFIRM CONDITIONS PRIOR TO CONSTRUCTION.
- 2. IF CONDITIONS DIFFER FROM THOSE SHOWN ON THE PLANS, THE CONTRACTOR SHALL NOTIFY THE ENGINEER AND SHALL NOT BEGIN CONSTRUCTION UNTIL THE CHANGED CONDITIONS HAVE BEEN EVALUATED.
- 3. THE CONTRACTOR SHALL TAKE PRECAUTIONARY MEASURES TO PROTECT THE UTILITY LINE CONDUITS OR PIPELINES SHOWN AND ANY OTHER IN-SERVICE LINES NOT OF RECORD OR NOT SHOWN ON THESE PLANS.
- 3. CALL THE UNDERGROUND LOCATOR LINE (1-800-424-5555) A MINIMUM OF 48 HOURS PRIOR TO ANY EXCAVATION.

#### **STORMWATER NOTES:**

- ALL WORKMANSHIP AND MATERIALS SHALL BE IN ACCORDANCE WITH COUNTY OF THURSTON STANDARDS, WSDFW STANDARDS AND THE MOST CURRENT COPY OF THE STATE OF WASHINGTON STANDARD SPECIFICATIONS FOR ROAD, BRIDGE AND MUNICIPAL CONSTRUCTION (WSDOT/APWA).
- 2. TEMPORARY EROSION /WATER POLLUTION PREVENTION MEASURES SHALL BE REQUIRED IN ACCORDANCE WITH WSDOT SECTION 1-07.15, AS MODIFIED BY THE APWA SUPPLEMENT, OF THE CURRENT STATE OF WASHINGTON STANDARD SPECIFICATIONS. SHOULD THE TEMPORARY EROSION AND SEDIMENTATION CONTROL MEASURES NOT PROVE ADEQUATE TO CONTROL EROSION AND SEDIMENTATION, THE APPLICANT/CONTRACTOR SHALL INSTALL ADDITIONAL FACILITIES AS NECESSARY TO PROTECT ADJACENT PROPERTIES, SENSITIVE AREAS, NATURAL WATER COURSES, AND/OR STORM DRAINAGE SYSTEMS.
- 3. ALL EROSION CONTROL AND STORMWATER FACILITIES SHALL BE REGULARLY INSPECTED AND MAINTAINED BY THE CONTRACTOR DURING CONSTRUCTION.

#### GENERAL EXCAVATION NOTES

1. THE EXISTENCE, LOCATION AND CHARACTERISTICS OF UNDERGROUND UTILITIES SHOWN ON THESE PLANS HAS BEEN OBTAINED FROM A REVIEW OF AVAILABLE RECORD DATA. NO REPRESENTATION IS MADE AS TO THE ACCURACY OR COMPLETENESS OF SAID UTILITY INFORMATION. THE CONTRACTOR SHALL POTHOLE OR OTHERWISE CONFIRM CONDITIONS. IF CONDITIONS DIFFER FROM THOSE SHOWN ON THE PLANS, THE CONTRACTOR SHALL NOTIFY THE ENGINEER AND SHALL NOT BEGIN CONSTRUCTION UNTIL THE CHANGED CONDITIONS HAVE BEEN EVALUATED. THE CONTRACTOR SHALL TAKE PRECAUTIONARY MEASURES TO PROTECT THE UTILITY LINES SHOWN AND ANY OTHER LINES NOT OF RECORD OR NOT SHOWN ON THESE PLANS.

K D f f Consulting Engineers

2407 North 31st Street, Suite 100 Tacoma, Washington 98407 (253) 396-0150 Fax (253) 396-0162



PROGRAM

SYM DATE REVISION DESCRIPTION APPROVED AND RELEASED FOR CONSTRUCTION CHIEF ENGINEER

. DATE:

BAR MEASURES ONE INCH ON ORIGINAL DRAWINGS DESIGNED BY MRK

CHECKED BY SWK

DRAWN BY MRK

DATE 01/31/13

SITE RENOVATION GENERAL NOTES

SUMMIT LAKE, ACCESS PROJECT NO. TN:A562:12-1

SHEET

TESC PLAN — CULVERT REPLACEMENT SCALE: 1" = 20'

BUMP SIGN

IE = /139.4/7

36" CPP

— 36" СРР

IE = 144.82

BUMP -

SUMMIT LAKE SHORE RD NW

KPFF CONTROL PT # 2

N: 9502.12

E: 9883.30

ELEV: 147.81

STRAW BALES

18" CMP IE = 131.84

LIMITS OF

USE EXISTING GATE AND FENCE AS CONSTRUCTION FENCING AND ENTRANCE.

SANDBAG DIVERSION BERM TO

DISTURBED AREA IS AT RISK OF EROSION OR TO PREVENT

SEDIMENT FROM LEAVING THE


BE INSTALLED ONLY IF

CONSTRUCTION SITE -

CONSTRUCTION -

#### EROSION AND SEDIMENTATION CONTROL (ESC) NOTES

- . FOR THE PURPOSES OF TEMPORARY EROSION/SEDIMENTATION CONTROL ON THIS PROJECT THE TERM "SEDIMENT" SHALL INCLUDE SOIL SEDIMENTS AS WELL AS SAWDUST, CONCRETE, AND OTHER DEBRIS OR PARTICULATE MATTER RESULTING FROM CONSTRUCTION ACTIVITIES.
- 2. ON-SITE EROSION CONTROL MEASURES SHALL BE THE RESPONSIBILITY OF THE CONTRACTOR. CONTRACTOR SHALL COMPLY WITH CONSTRUCTION STORMWATER PERMIT INCLUDING PREPARATION OF A STORMWATER POLLUTION PREVENTION PLAN AND IMPLEMENTATION OF BEST MANAGEMENT PRACTICES. ANY PROBLEMS OCCURRING BEFORE FINAL ACCEPTANCE OF THE PROJECT SHALL BE CORRECTED BY THE CONTRACTOR.
- . IN THE EVENT THAT EROSION OR SEDIMENTATION OCCURS ON ADJACENT PROPERTY, ALL CONSTRUCTION WORK THAT WILL AGGRAVATE THE SITUATION MUST CEASE AND THE CONTRACTOR SHALL IMMEDIATELY COMMENCE RESTORATION OR MITIGATION MEASURES. RESTORATION ACTIVITY SHALL CONTINUE UNTIL SUCH TIME AS THE PROBLEM IS RECTIFIED.
- . ALL EROSION AND SEDIMENTATION CONTROL DEVICES SHALL BE INSTALLED PRIOR TO THE FIRST STAGE OF SITE PREPARATION.
- 5. SHOULD THE TEMPORARY EROSION AND SEDIMENTATION CONTROL MEASURES NOT PROVE ADEQUATE TO CONTROL EROSION AND SEDIMENTATION, THE CONTRACTOR SHALL INSTALL ADDITIONAL FACILITIES, AS NECESSARY, TO PROTECT ADJACENT PROPERTIES, SENSITIVE AREAS, NATURAL WATER COURSES AND/OR STORM DRAINAGE SYSTEMS.
- 3. IN ANY AREA WHICH HAS BEEN STRIPPED OF VEGETATION OR EXPERIENCED LAND DISTURBING ACTIVITIES, AND WHERE NO FURTHER WORK IS ANTICIPATED FOR A PERIOD EXCEEDING 48 HRS, ALL DISTURBED AREAS MUST BE
- . ALL NECESSARY FACILITIES SHALL BE MAINTAINED ON-SITE TO PREVENT DEBRIS, DUST AND MUD FROM ENTERING AND/OR ACCUMULATING IN THE PUBLIC RIGHT-OF-WAY OR SUMMIT LAKE.
- . THE ESC FACILITIES SHOWN ON THIS SHEET ARE THE MINIMUM REQUIREMENTS FOR ANTICIPATED SITE CONDITIONS DURING THE CONSTRUCTION PERIOD. THESE ESC FACILIITES SHALL BE UPGRADED AS NEEDED FOR UNEXPECTED STORM EVENTS AND TO ENSURE THAT SEDIMENT AND SEDIMENT—LADEN WATER DO NOT ENTER SUMMIT LAKE OR LEAVE THE SITE.
- 9. THE ESC FACILITIES SHALL BE INSPECTED DAILY BY THE CONTRACTOR AND MAINTAINED AS NECESSARY OR AS DIRECTED BY THE ENGINEER TO ENSURE THEIR CONTINUED FUNCTIONING.
- 10. THE ESC FACILITIES ON INACTIVE AREAS OF THE SITE SHALL BE CONTINUOUSLY MAINTAINED AND INSPECTED A MINIMUM OF ONCE A MONTH OR WITHIN 48 HOURS FOLLOWING A MAJOR STORM EVENT.
- 11. THE CONTRACTOR SHALL PROTECT STOCKPILE AND EXCAVATION AREAS FROM THE RELEASE OF SEDIMENT. STOCKPILES SHALL BE COVERED AT ALL TIMES WHILE NOT IN USE TO KEEP THE STORED MATERIAL DRY.
- 12. SANDBAGS, GEOFABRIC AND/OR OTHER METHODS SHALL BE USED AROUND STOCKPILE AND EXCAVATION AREAS TO PREVENT RUNOFF OF SEDIMENTS.
- 13. ALL TEMPORARY EROSION AND SEDIMENT CONTROLS SHALL REMAIN UNTIL FINAL SITE STABILIZATION IS ACHIEVED OR AFTER THE TEMPORARY CONTROLS ARE NO LONGER NEEDED, WHICHEVER IS LATER. TRAPPED SEDIMENT SHALL BE REMOVED FROM THE SITE AND DISPOSED OF PROPERLY.

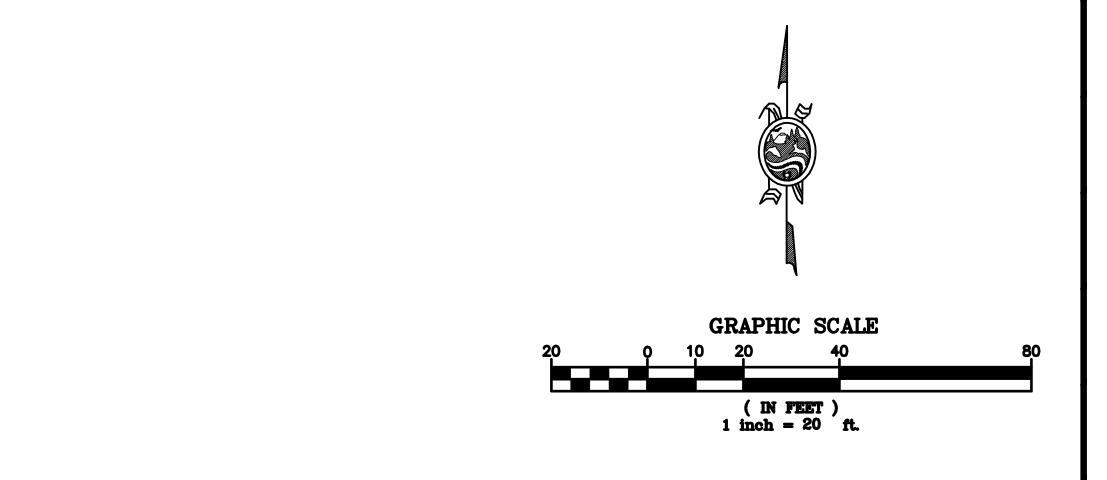

**Kpff** Consulting Engine

2407 North 31st Street, Suite 100 Tacoma, Washington 98407 (253) 396-0150 Fax (253) 396-0162 WASHINGTON STATE

DEPARTMENT OF FISH AND WILDLIFE

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SITE RENOVATION

TEMPORARY EROSION &

SEDIMENTATION CONTROL PLAN

SUMMIT LAKE, ACCESS

TN:A562:12-1

SHEET OF

PROJECT NO.

IE = 155.72


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## — GEOTEXTILE FOR TEMPORARY SILT FENCE ~ SEE WSDOT STD. SPEC. 9-33.2(1), TABLE 6 - WHEN SPECIFIED IN THE CONTRACT, INSTALL BACKUP SUPPORT FOR THE GEOTEXTILE ~ SEE WSDOT STD. SPEC. 8.01.3(9)A) 6'-0" MAX SPACING WITHOUT BACKUP SUPPORT 10'-0" MAX SPACING WITH BACKUP SUPPORT

**ELEVATION VIEW** 

#### NOTES:

- 1. MAXIMIZE DETENTION OF STORMWATER BY PLACING FENCE AS FAR AWAY FROM TOE OF SLOPE AS POSSIBLE WITHOUT ENCROACHING ON SENSITIVE AREAS OR OUTSIDE OF THE CLEARING BOUNDARIES.
- 2. INSTALL SILT FENCING ALONG CONTOURS WHENEVER POSSIBLE.
- 3. INSTALL THE ENDS OF THE SILT FENCE TO POINT SLIGHTLY UP-SLOPE TO PRE-VENT SEDIMENT FROM FLOWING AROUND THE ENDS OF THE
- 4. PERFORM MAINTENANCE IN ACCORDANCE WITH WSDOT STANDARD SPECIFICATIONS 8.01.3(9)A AND 8.01.3(15).

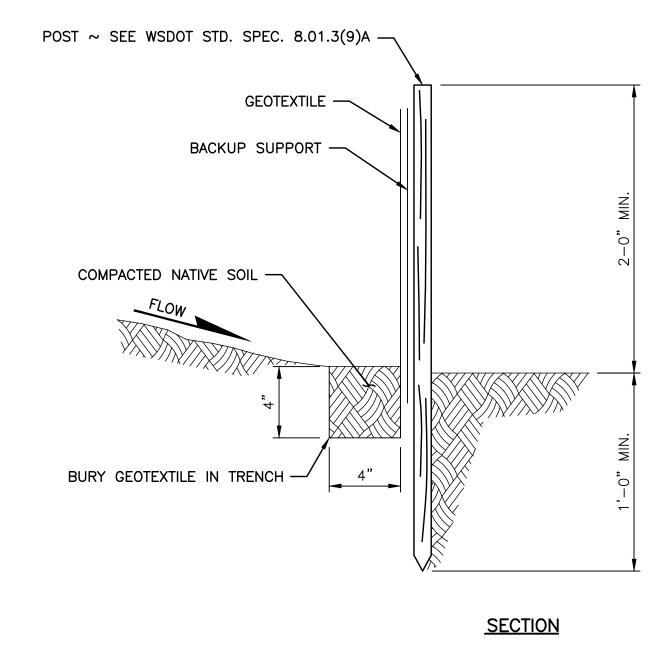


POLYSTYRENE FLOTATION TUBE, CONTINUOUS, INSERTED IN SLEEVE OF GEOSYNTHETIC. — ANCHOR ROPES TO MAINTAIN POSITION OF CURTAIN ─ 315 LB. WOVEN GEOSYNTHETIC, 5' DEPTH WITH 1/4" GALV CHAIN SEWN INTO GEOSYNTHETIC POCKET AT BOTTOM воттом

— 6"ø EXPANDED

#### NOTES:

- SILT CURTAIN AVAILABLE FROM NORTHWEST LININGS, KENT, WA.
- 2. GEOSYNTHETIC SHALL BE PERMEATEX 2315 OR EQUAL.
- 3. SEE PERMITS PRIOR TO INSTALLATION.

SILT FENCE ELEVATION 1

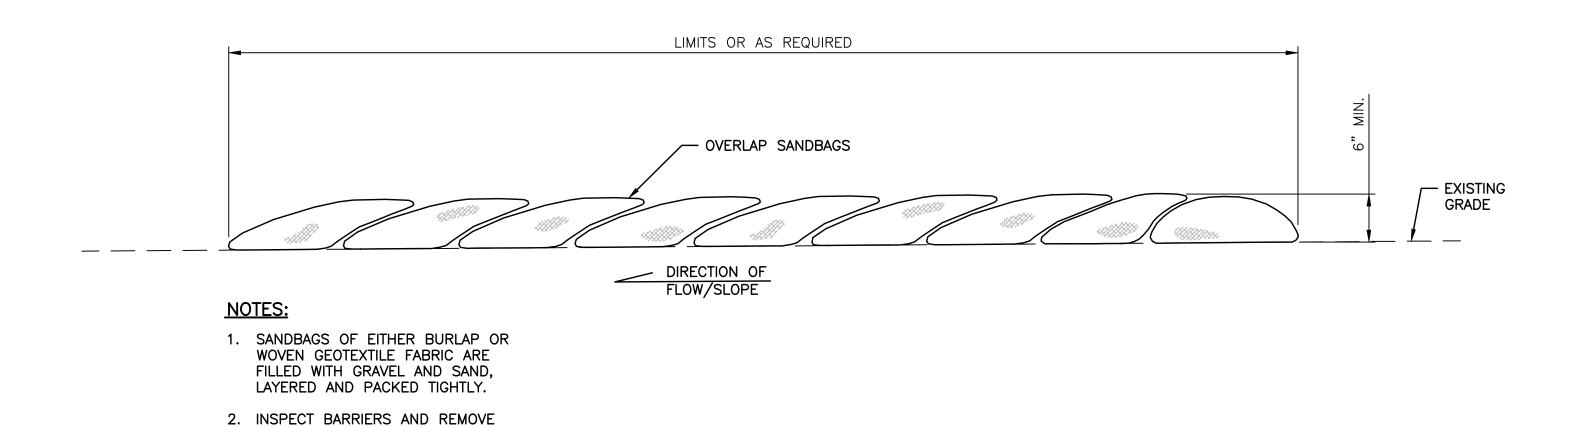

SANDBAG DIVERSION BERM DETAIL 2
NOT TO SCALE 4 5


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(253) 396-0150

Fax (253) 396-0162

SEDIMENT AFTER EACH STORM

WASHINGTON STATE DEPARTMENT OF FISH AND WILDLIFE

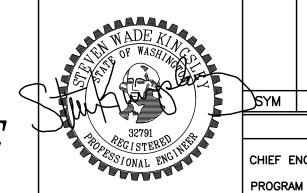

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BAR MEASURES ONE INCH ON ORIGINAL DRAWINGS

SUMMIT LAKE, ACCESS SITE RENOVATION TEMPORARY EROSION & CHECKED BY SWK SEDIMENTATION CONTROL-NOTES & DETAILS DATE 01/31/13

PROJECT NO. TN:A562:12-1

SHEET


DEMOLITION PLAN — CULVERT REPLACEMENT

#### CRACK SEALING NOTE:

- 1. CRACKS SHALL BE SEALED AND FULLY CURED PRIOR TO ASPHALT OVERLAY.
- 2. CONTRACTOR SHALL SEAL CRACKS AS IDENTIFIED ON THE PLANS AND ANY CRACKS WIDER THAN 1/4" WITHIN THE LIMITS OF ASPHALT OVERLAY AREA.
- 3. CRACK SEALING SHALL BE PER WSDOT SPECIFICATION 5-04.3(5)C-CRACK SEALING.

ALL CRACKS AND JOINTS 1/4" AND GREATER IN WIDTH SHALL BE CLEANED WITH A CHIPPING HAMMER, STIFF BRISTLED BROOM AND COMPRESSED AIR TO REMOVE ALL DIRT, DEBRIS AND LOOSE PAVEMENT MATERIAL; AND THEN SHALL BE FILLED COMPLETELY WITH SAND SLURRY.

THE SAND SLURRY SHALL CONSIST OF APPROXIMATELY 20 PERCENT CSS-1 EMULSIFIED ASPHALT, APPROXIMATELY 2 PERCENT PORTLAND CEMENT, WATER (IF REQUIRED), AND THE REMAINDER CLEAN NO. 4-0 PAVING SAND. THE COMPONENTS SHALL BE THOROUGHLY MIXED AND THEN POURED INTO THE CRACKS AND JOINTS UNTIL FULL. THE FOLLOWING DAY, ANY CRACKS OR JOINTS THAT ARE NOT THAT ARE NOT COMPLETELY FILLED SHALL BE TOPPED OFF WITH ADDITIONAL SAND SLURRY. AFTER THE SAND SLURRY IS PLACED, THE FILLER SHALL BE STRUCK OFF FLUSH WITH THE EXISTING PAVEMENT SURFACE AND ALLOWED TO CURE. THE HMA OVERLAY SHALL NOT BE PLACED UNTIL THE SLURRY HAS FULLY CURED.

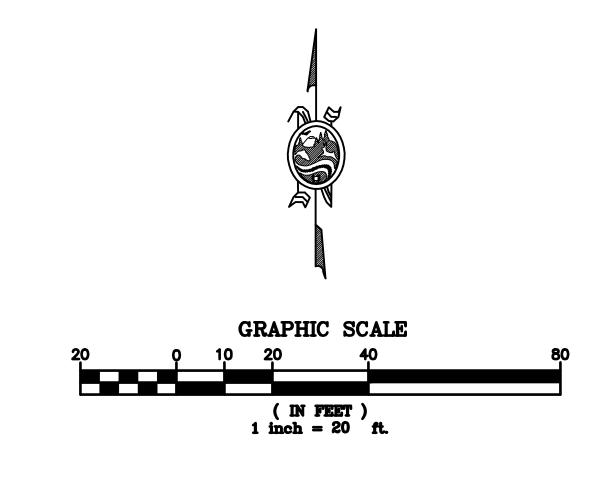

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WASHINGTON STATE DEPARTMENT OF FISH AND WILDLIFE


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SUMMIT LAKE, ACCESS SITE RENOVATION DEMOLITION PLAN

PROJECT NO. TN:A562:12-1

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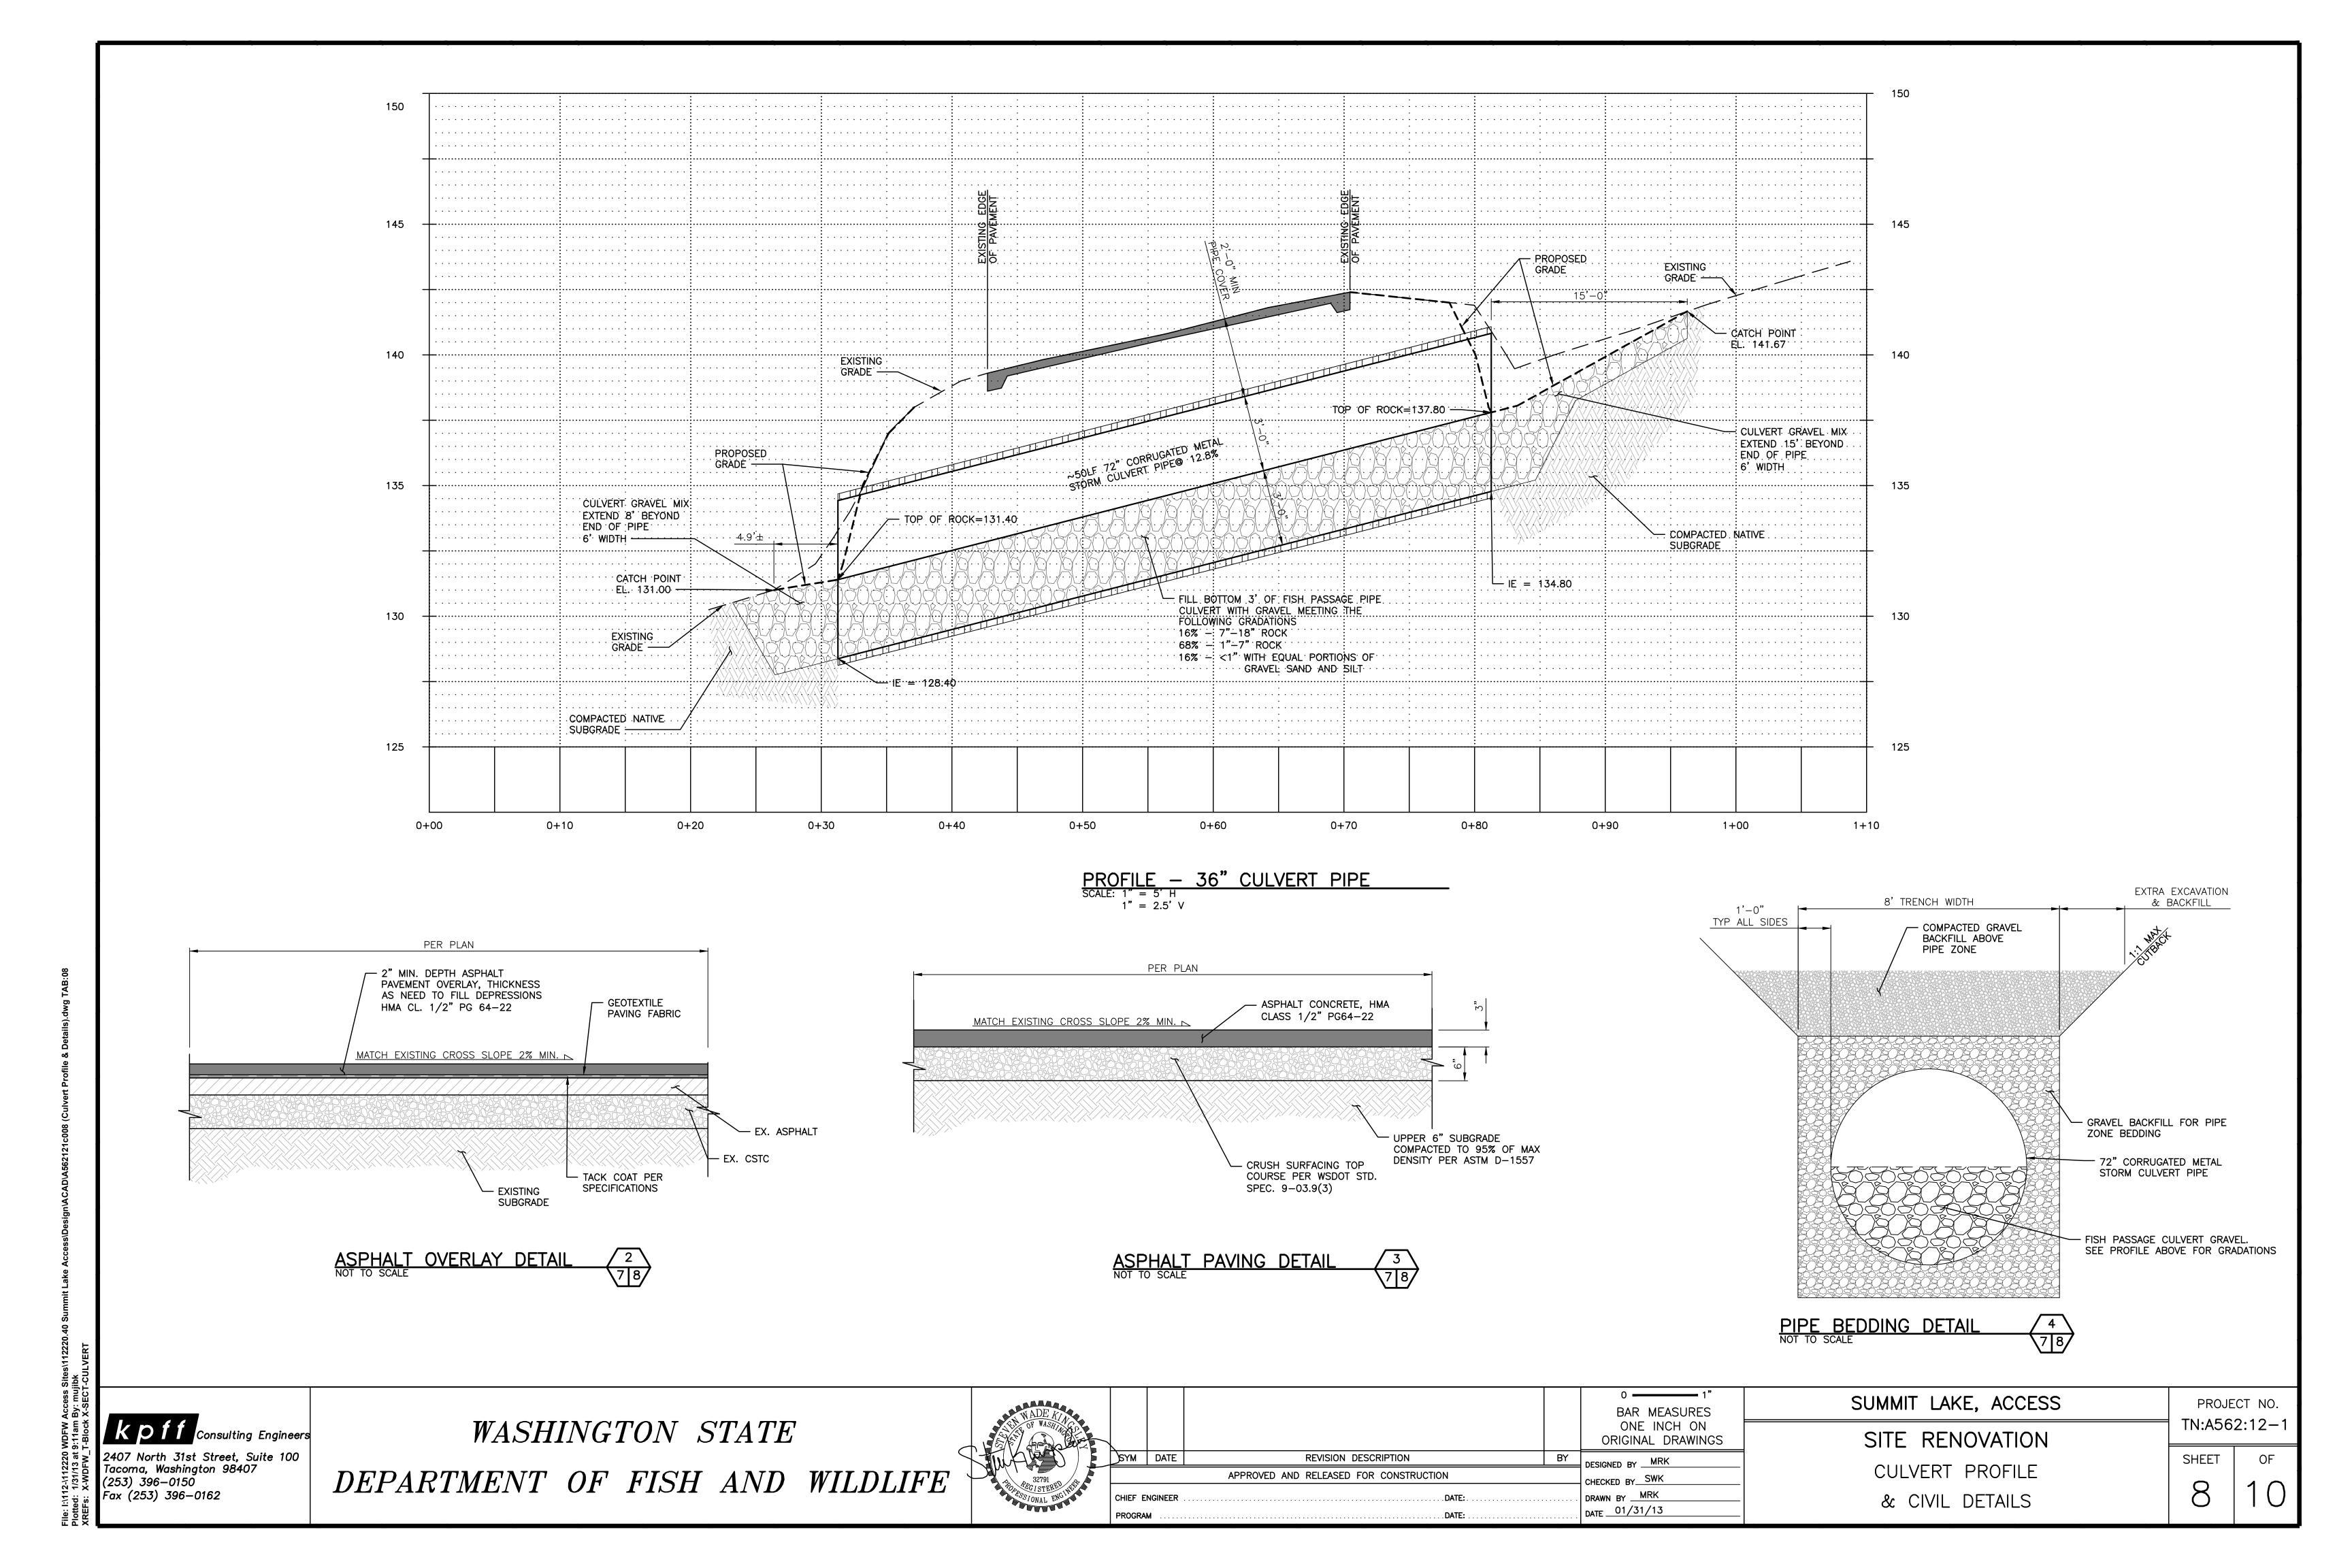
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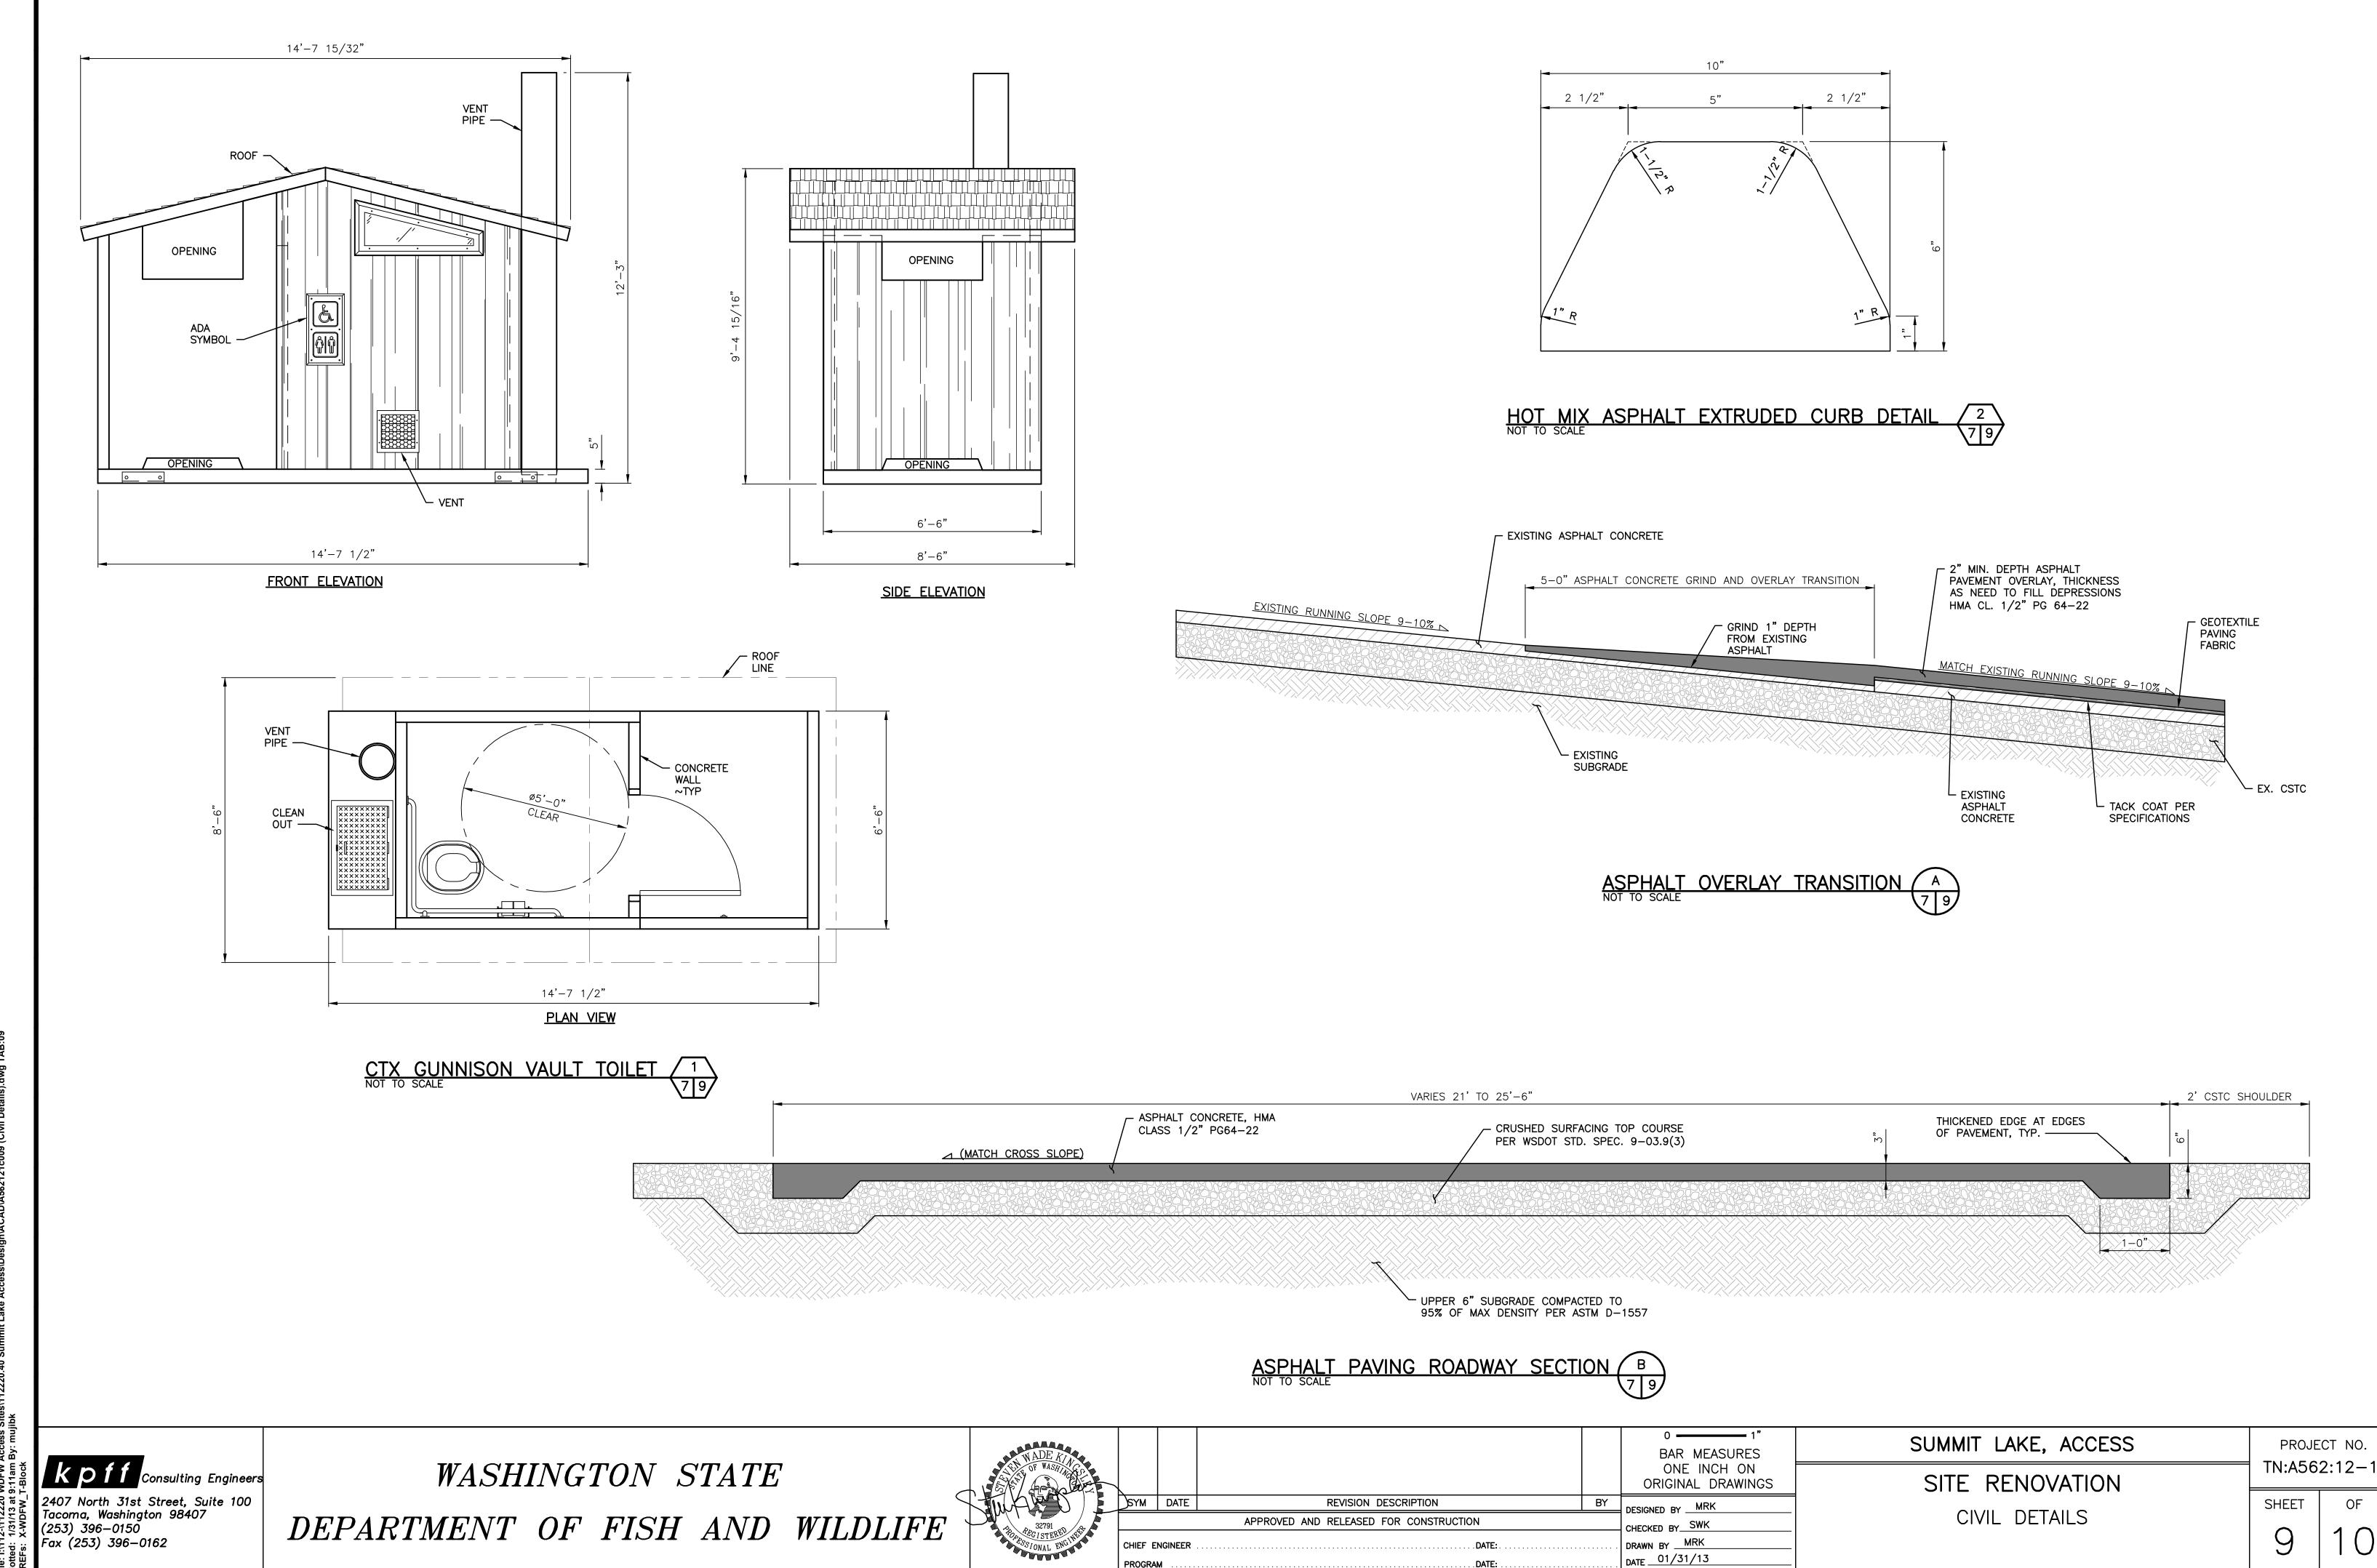
DEPARTMENT OF FISH AND WILDLIFE

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SITE PLAN



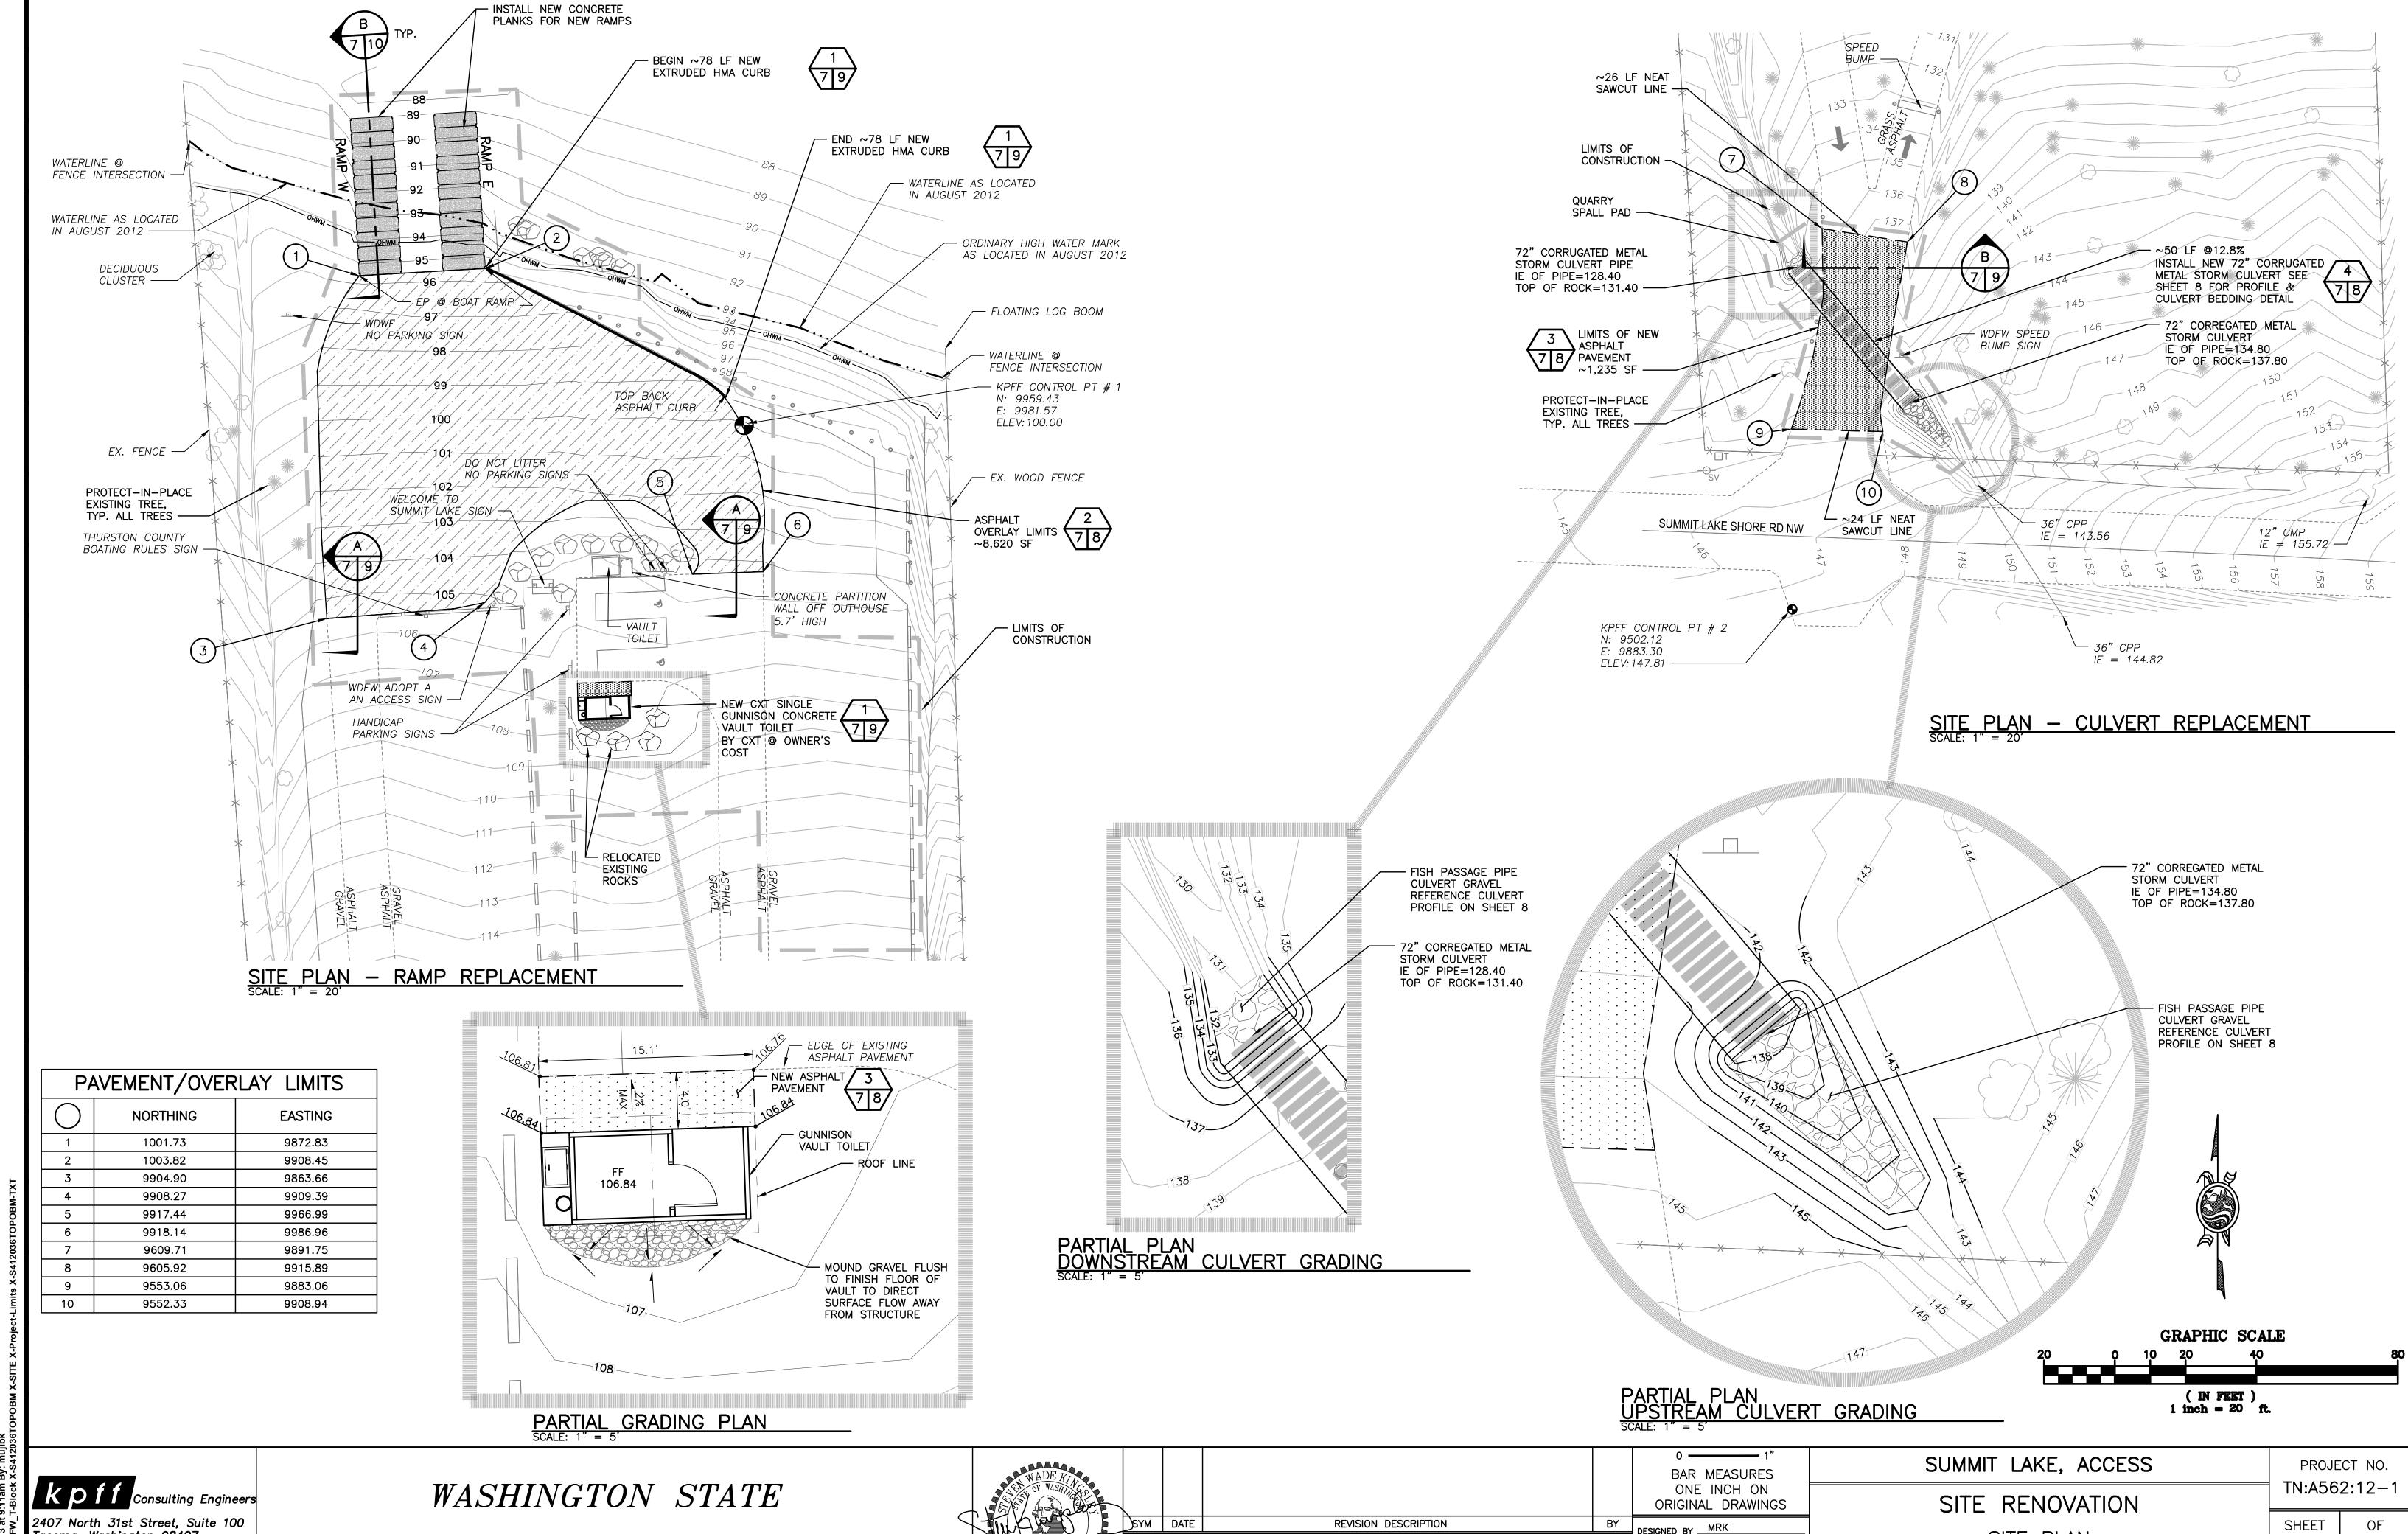

. . **DATE:** .

